4-PLEX RU1

PROJECT INFO:

652 BERK COURT

LIST OF DRAWINGS:

Legal Description:

SHEET INDEX: PID: 028-949-331

Plan: EPP5534 Lot: 1

TOTAL PARKING STALLS

Zone: RU1

COVER SHEET, SITE PLAN, STREETSCAPE

MAIN FLOOR PLAN MIDDLE FLOOR PLAN UPPER FLOOR PLAN

> **ELEVATIONS ELEVATIONS**

ZONING COMPLIANCE SUMMARY				
MUNICIPALITY:		CITY OF KELOWNA		
CIVIC ADDRESS:		652 BERK COURT		
LOT AREA:		588.46 m ²		
ZONE:		RU1		
DEVELOPMENT REGULATIONS	REQUIRED	PROPOSED		
BUILDING LOT COVERAGE	55%	38.5%		
SITE COVERAGE INCL. NON-PERMEABLE SURFAC	ES 70%	68.0%		
SETBACK REGULATIONS	REQUIRED	PROPOSED		
FRONT	3.0 m	3.076 m		
LEFT	2.1 m	3.610 m		
REAR	3.0 m	3.147 m		
RIGHT	2.1 m	2.957 m		
BUILDING HEIGHT REQUIREMENTS	REQUIRED	PROPOSED		
MAXIMUM HEIGHT	11 m	9.439 m		
OFF STREE PARKING REQUIREMENTS				
(4) 4 BEDROOM UNITS	(5) STALLS 2.5 m x 6.0 m	(5) STALLS 2.5 m x 6.0 m		



(DOES NOT INCLUDE SERVICE PATHWAYS)

SERVICE PATHWAYS COVER 8.0%

EPP5534



PERSPECTIVE VIEW STREETSCAPE VIEW





GENERAL NOTES

1. ALL CONSTRUCTION AND BUILDING TO BE IN ACCORDANCE TO THE LATEST BRITISH COLUMBIA BUILDING CODE (2024).

2. CONSTRUCTION TO COMMENCE IN ACCORDANCE TO ALL LOCAL BYLAWS.

3. DRAWINGS ARE NOT TO BE SCALED. ALL DIMENSIONS ARE TO WALL CENTERLINES AND EXTERIOR OF SHEATHING.


4. CONTRACTORS ARE TO REVIEW ALL DRAWINGS AND REPORT ANY

DISCREPANCIES AND ERRORS PRIOR TO CONSTRUCTION. 5. PRIOR TO PROCEEDING WITH CONSTRUCTION THE OWNER/BUILDER IS TO ENSURE ALL REQUIRED INSURANCES AND WORKSAFE BC

CONFORMANCE ARE IN PLACE PRIOR TO COMMENCEMENT OF CONSTRUCTION. IT IS THE RESPONSIBILITY OF ALL TRADES TO CHECK AND VERIFY ALL DIMENSIONS AND DETAILS BEFORE COMMENCING CONSTRUCTION.

6. LICENSED AND INSURED PROFESSIONALS MUST VERIFY ALL INFORMATION, DIMENSIONS, SPECIFICATIONS OF THIS PLAN PRIOR TO CONSTRUCTION.

7. ERRORS AND OMISSIONS. ZIOLA DESIGN & BRENT ZIOLA SHALL NOT BE RESPONSIBLE FOR ANY VARIATIONS OR ADJUSTMENTS RESULTING IN CONDITIONS ENCOUNTERED AT THE JOB SITE, AND IS THE SOLE RESPONSIBILITY OF THE OWNER OR CONTRACTOR. EVERY EFFORT HAS BEEN MADE TO PROVIDE COMPLETE AND ACCURATE DRAWINGS. ZIOLA DESIGN OR ITS TECHNICIANS CAN NOT ELIMINATE THE POSSIBILITY OF HUMAN ERROR, THEREFORE DRAFTING TECHNICIANS, OR ZIOLA DESIGN OR BRENT ZIOLA SHALL NOT BE LIABLE FOR ANY ERRORS OR OMISSIONS.

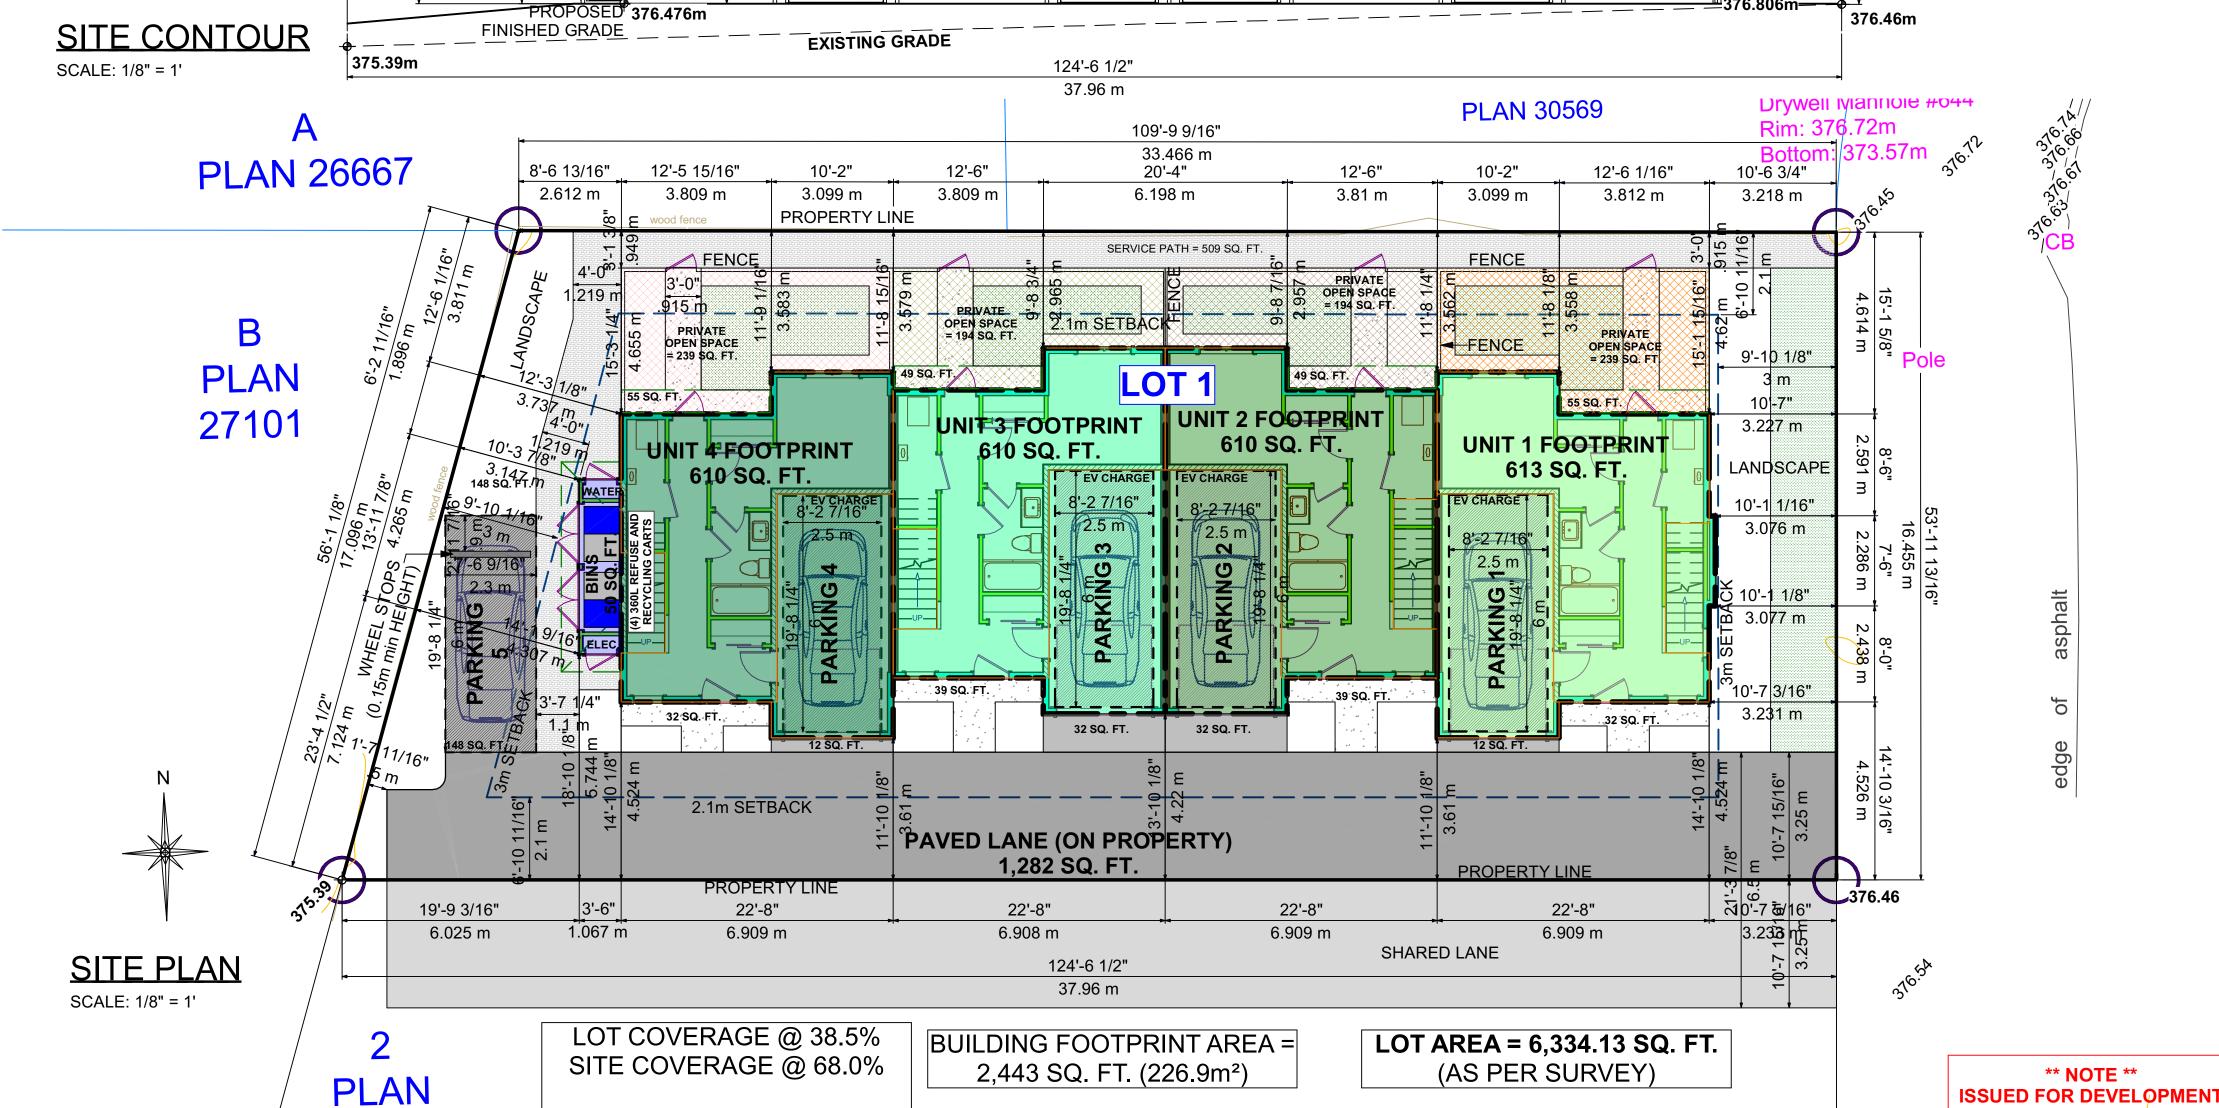

1631 DICKSON AVE #1100 KELOWNA, BC PHONE: 778 363 4421 reception@zioladesign.com WWW.ZIOLADESIGN.COM

MENETHIL GROUP

CONTACT: **SEAN PAXMAN** (236) 998-8111

OWNA BERK 652 KEL

TITLE SITE PLAN

1/8" = 1'-0" DATE

OCT-30-2024 PROJECT DRAWING

NUMBER NUMBER Z-154-09 2.1

SHEET

PERMIT ONLY.

NOT FOR CONSTRUCTION.

SCALE

4 BEDROOM UNITS

16 BEDROOMS TOTAL

ALL UNITS TOTAL FLOOR AREA: 5,516 SQ. FT.

WALL LEGEND

2x6" BEARING WALL INTERIOR

2x6" WALL W/ DRYWALL

2x4" BEARING WALL INTERIOR

2x4" WALL W/ DRYWALL

2x4" HALF-WALL (42" HIGH)

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MENETHIL GROUP

CONTACT: SEAN PAXMAN

(236) 998-8111

OWNA

652

KEL

TITLE GROUND FLOOR

SCALE 3/16" = 1'-0"


OCT-30-2024

PROJECT DRAWING NUMBER NUMBER

Z-154-09 2.1

SHEET

** NOTE ** **ISSUED FOR DEVELOPMENT** PERMIT ONLY. NOT FOR CONSTRUCTION.

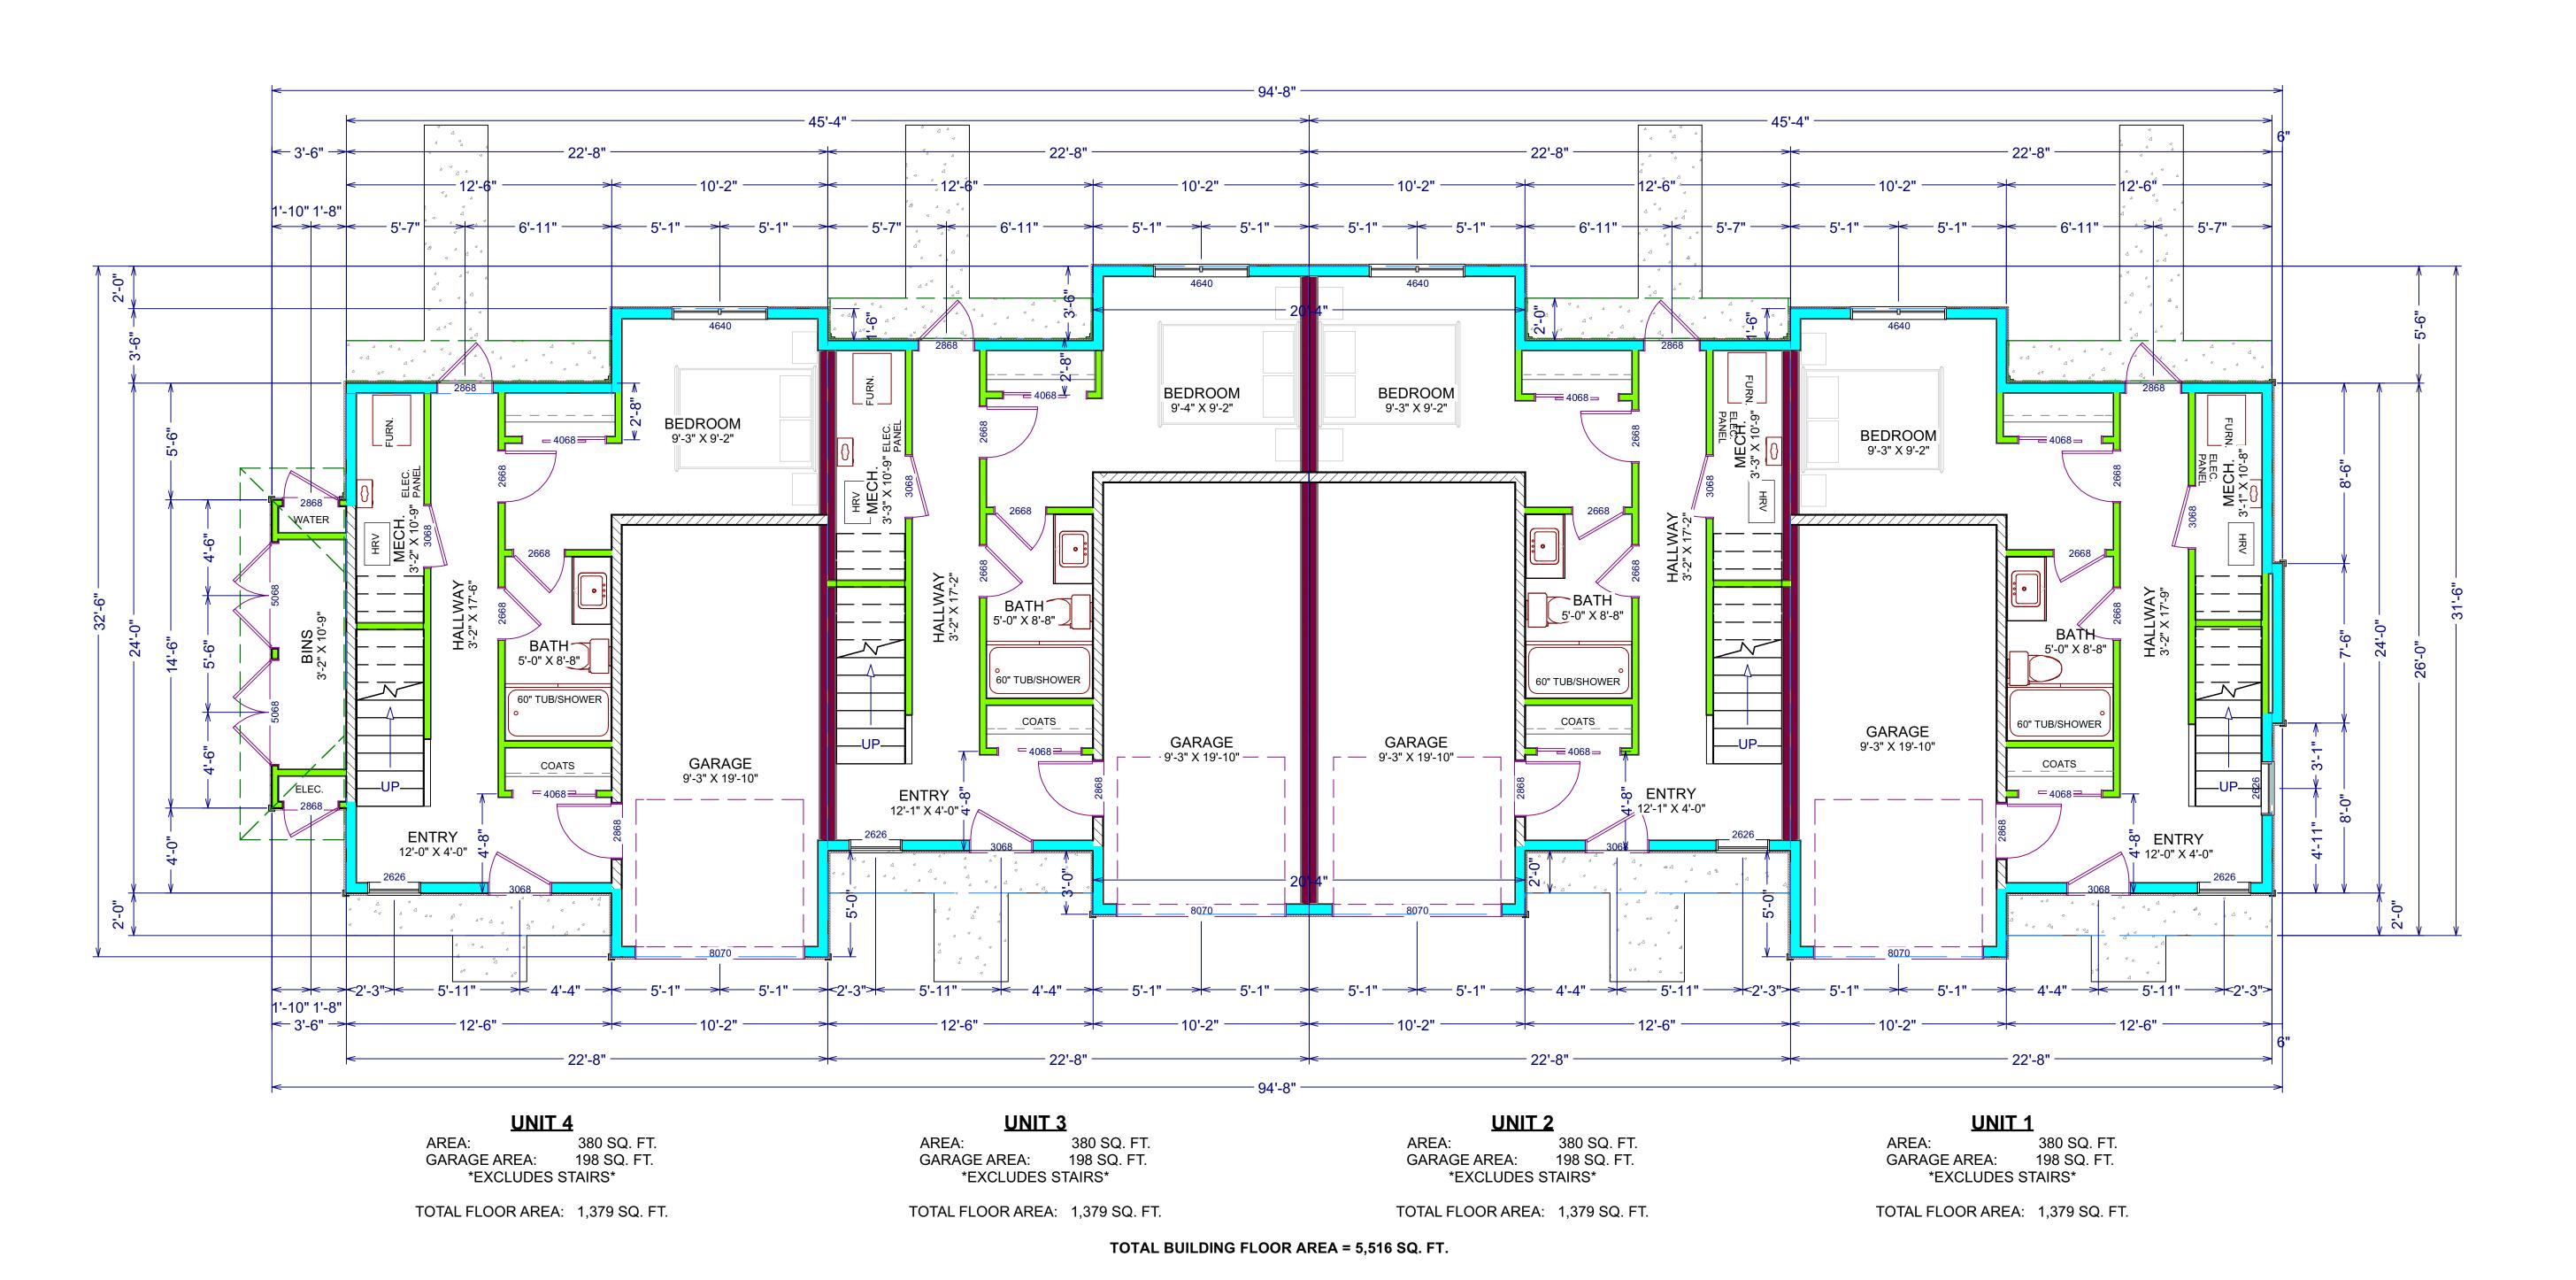



WALL LEGEND

2x6" BEARING WALL INTERIOR

2x6" WALL W/ DRYWALL

2x4" BEARING WALL INTERIOR

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reception@zioladesign.com WWW.ZIOLADESIGN.COM

GROUP

CONTACT: SEAN PAXMAN (236) 998-8111

BERK OWNA 652 KEL

TITLE MIDDLE FLOOR

SCALE

DATE OCT-30-2024

PROJECT DRAWING NUMBER NUMBER

2.1

Z-154-09 SHEET

** NOTE **

ISSUED FOR DEVELOPMENT

PERMIT ONLY.

CONSTRUCT



WALL LEGEND

2x4" HALF-WALL (42" HIGH)

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MENETHIL GROUP

CONTACT: SEAN PAXMAN (236) 998-8111

BERK OWNA 652 KEL

TITLE UPPER FLOOR

SCALE

DATE OCT-30-2024

PROJECT DRAWING NUMBER NUMBER Z-154-09 2.1


SHEET

** NOTE **

ISSUED FOR DEVELOPMENT


PERMIT ONLY.

OR CONSTRUCT

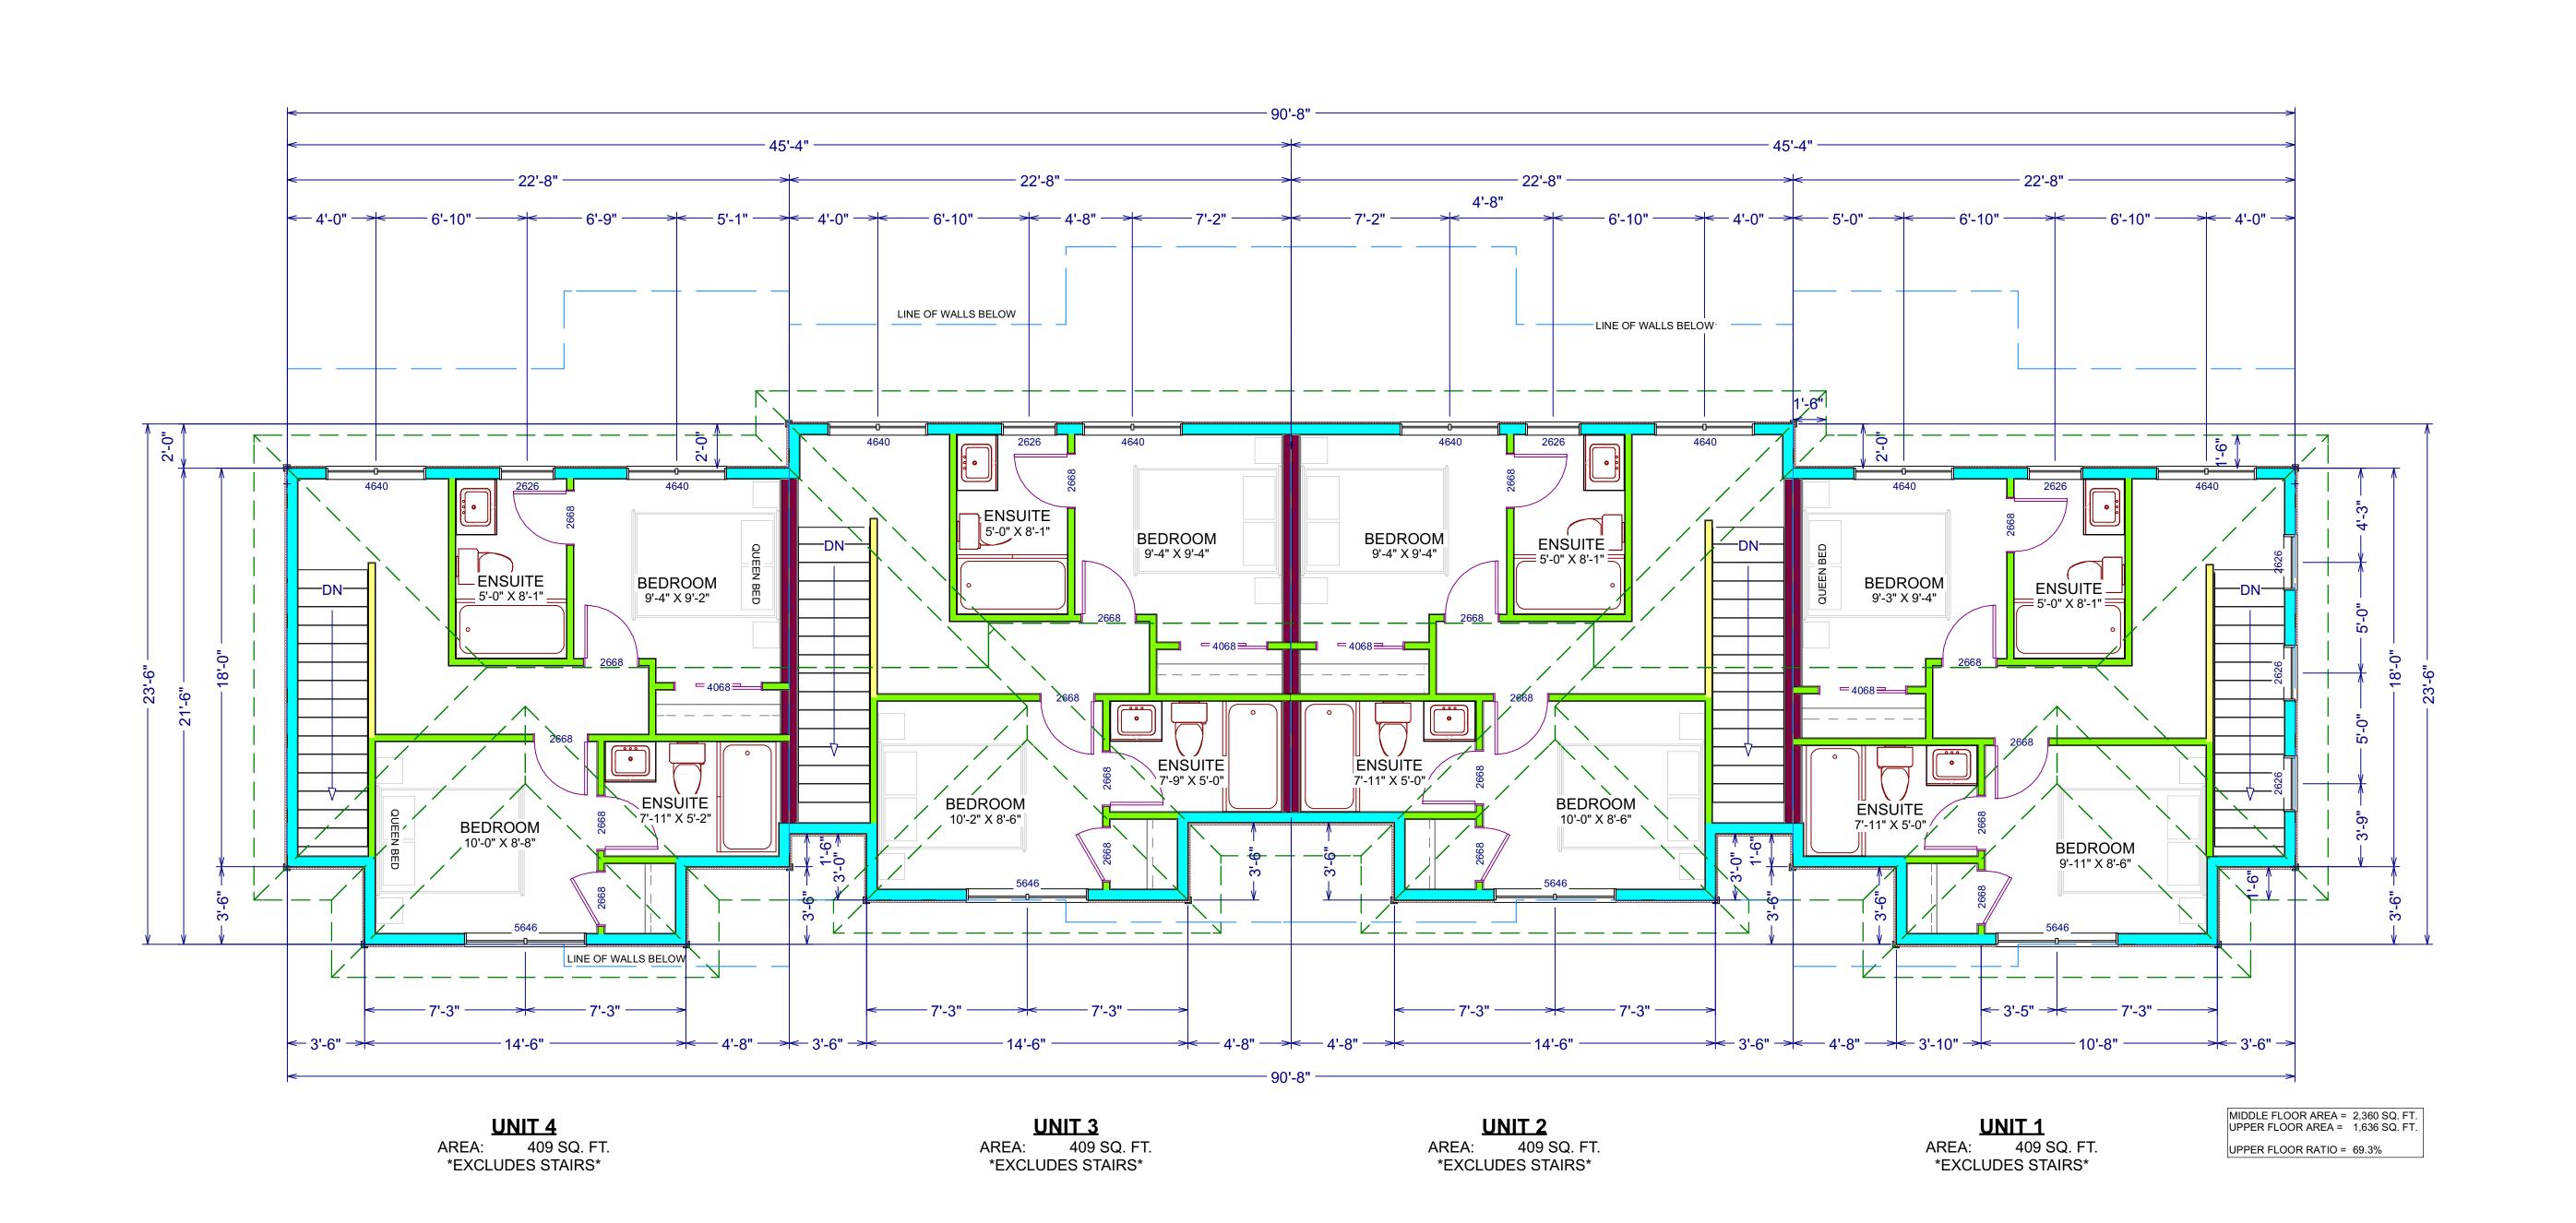



FRONT ELEVATION

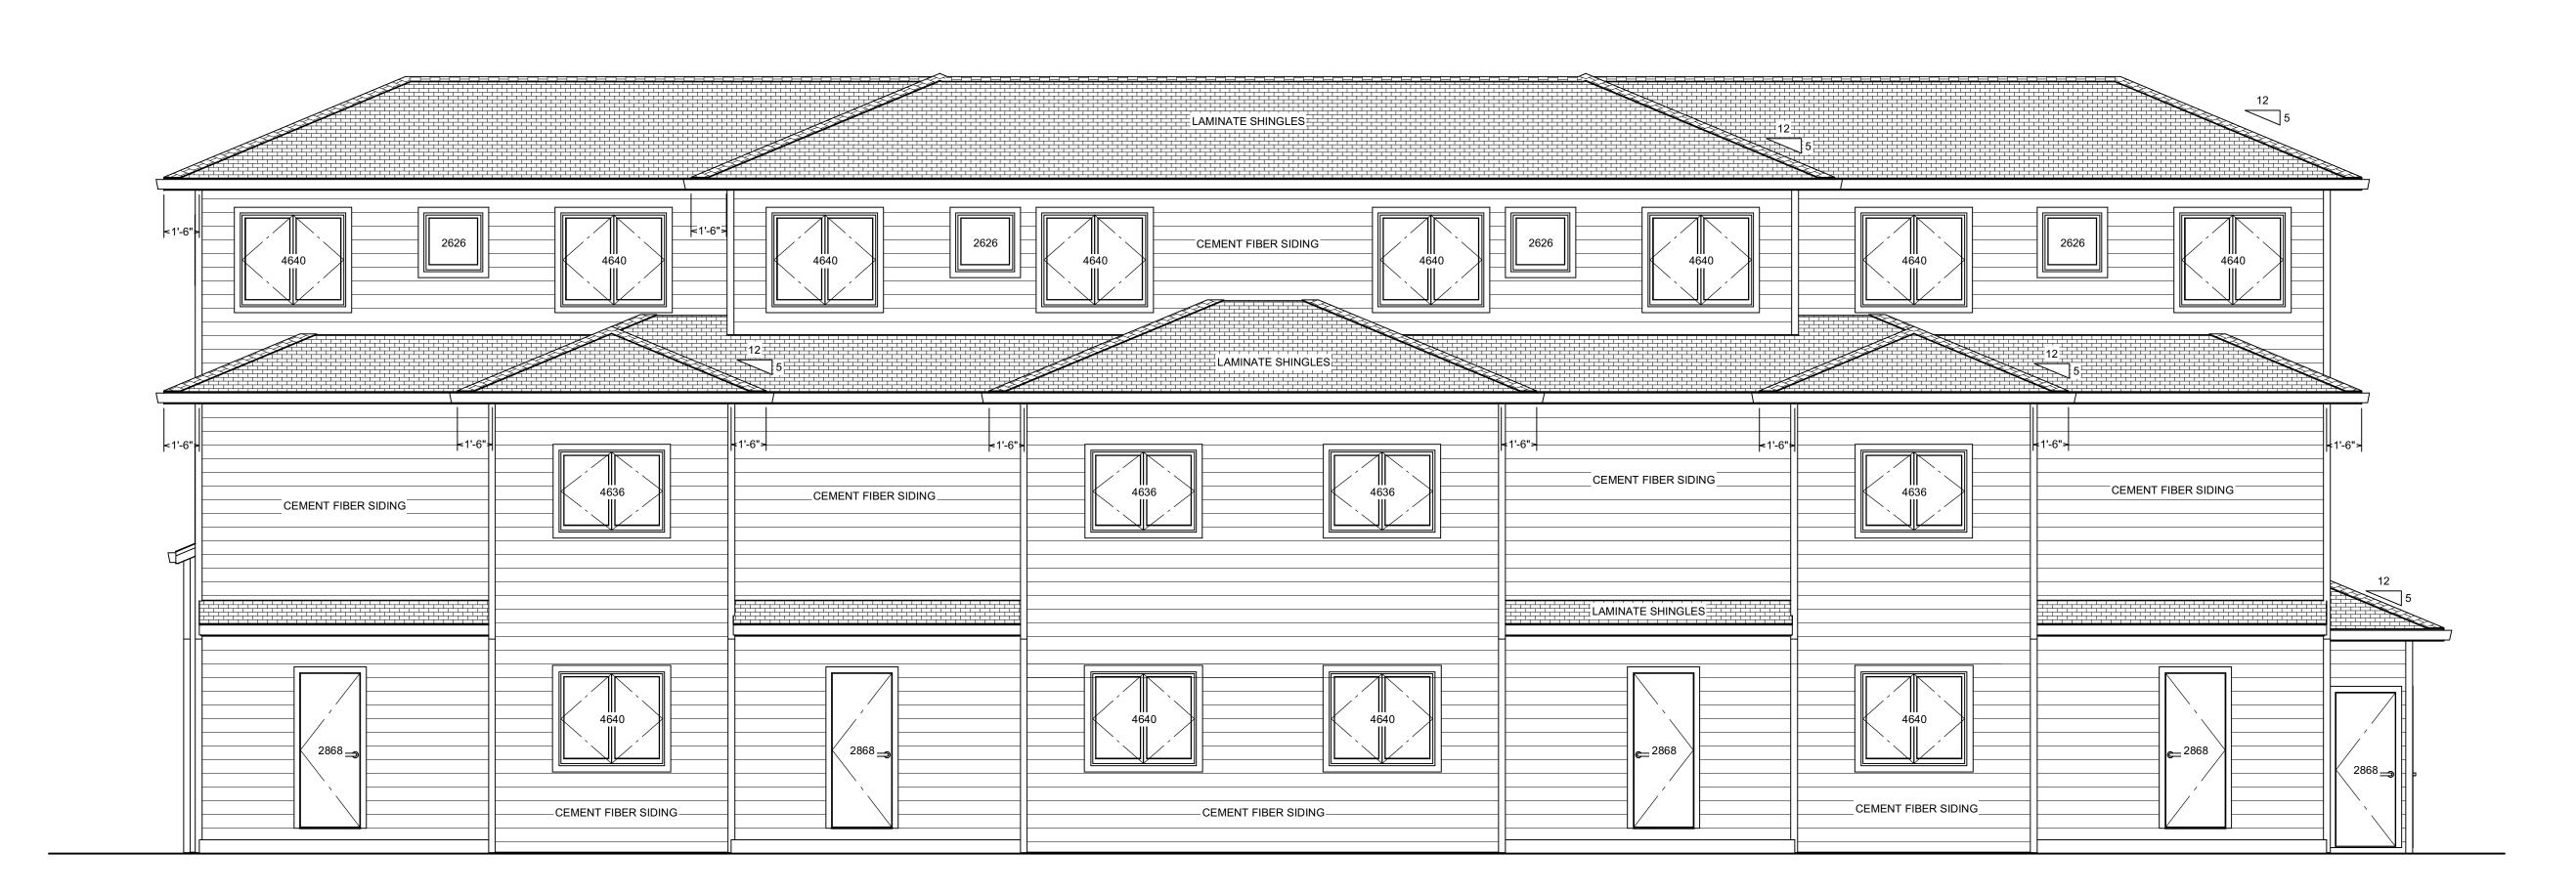

REAR ELEVATION

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KELOWNA, BC
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CONTACT: SEAN PAXMAN (236) 998-8111

652 BERK CT. KELOWNA, BC

ROJECT TITLE

TITLE ELEVATIONS

SCALE

DATE OCT-30-2024


PROJECT DRAWING NUMBER NUMBER 2.1

SHEET

** NOTE **
ISSUED FOR DEVELOPMENT
PERMIT ONLY.

NOT FOR CONSTRUCTION.

5 of 6

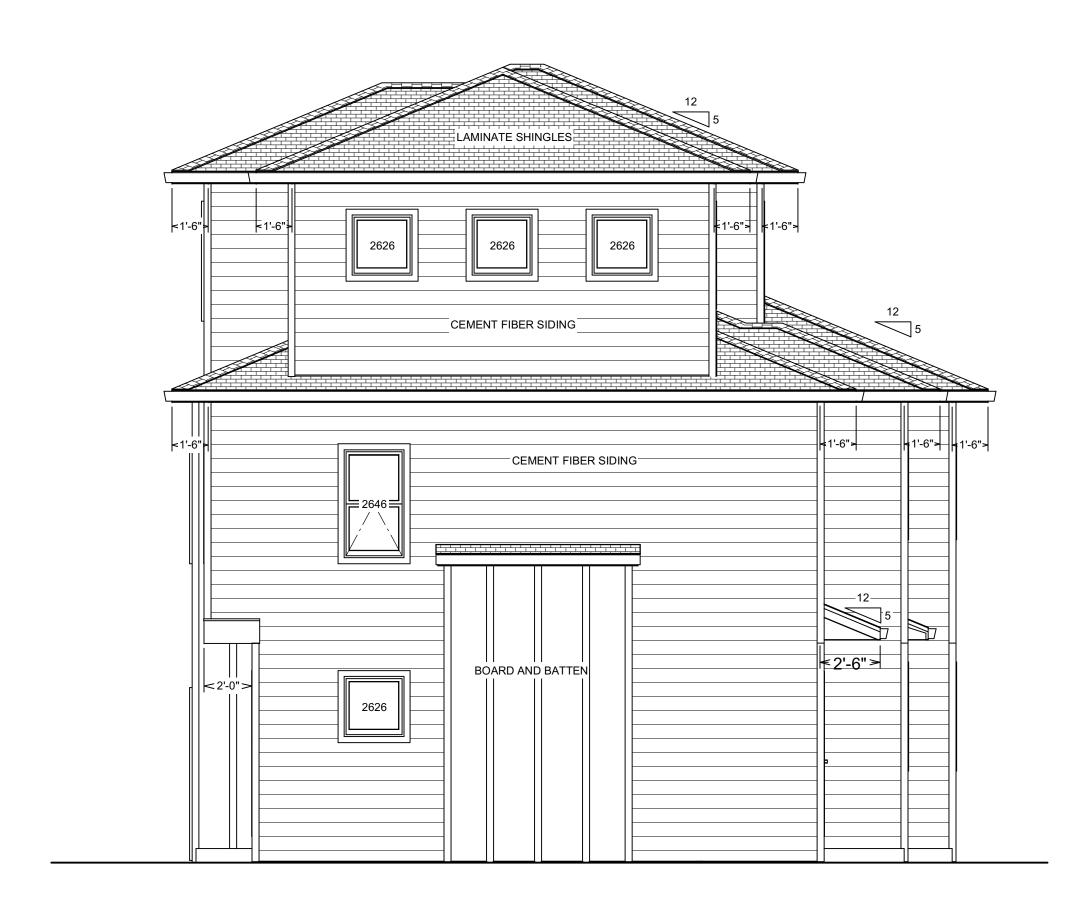

RIGHT ELEVATION



LEFT ELEVATION



	MATERIAL BOARD						
1.	BOARD AND BATTEN	COLOUR: ONYX (BLACK)		5.	ALUMINUM SOFFIT	COLOUR: BLACK	
2.	CEMENT FIBER SIDING	COLOUR: ARCTIC WHITE	AACTE BRITE	6.	WINDOW SILL	COLOUR: BLACK	
3.	L.P SMART TRIM BD.	COLOUR: ONYX (BLACK)		7.	LAMINATE SHINGLES	COLOUR: ONYX (BLACK)	Over Blast*
4.	CEMENT FIBER SIDING	COLOUR: BLACK (ABYSS)					



** NOTE **
ISSUED FOR DEVELOPMENT
PERMIT ONLY.
NOT FOR CONSTRUCTION.

ZIOLA

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MENETHIL GROUP

CONTACT: SEAN PAXMAN (236) 998-8111

652 BERK CT. KELOWNA, BC

TITLE ELEVATIONS

SCALE

DATE OCT-30-2024

PROJECT DRAWING NUMBER NUMBER

Z-154-09 2.1

SHEET

6 OF





1) LANDSCAPE STANDARD

WORK OF THE CONTRACTOR SHALL MEET OR EXCEED ALL SPECIFICATIONS AND STANDARDS ESTABLISHED IN THE LATEST VERSION OF SECTION 7 IN CITY OF KELOWNA BYLAW 12375 AND THE CANADIAN LANDSCAPE ASSOCIATION (CNLA) AND THE CANADIAN SOCIETY OF LANDSCAPE ARCHITECTS (CSLA)).

2) INSPECTIONS

THE CONTRACTOR SHALL GIVE THE SITE INSPECTOR 48 HOURS NOTICE BEFORE ALL REQUIRED INSPECTIONS.

THE CONTRACTOR SHALL SUPPLY AND PLACE DOUGLAS RED FIR MULCH, AT 75MM DEPTH (MIN.) TO THE BASE OF EACH OF THE INSTALLED PLANTS & ANY TREES IN TURF TO HAVE A MINIMUM 2M DIAM. RING OF WOOD MULCH AS SHOWN ON THE DRAWINGS. NO PLASTIC FILM OR WEED BARRIER FABRIC IS PERMITTED UNLESS OTHERWISE SPECIFIED ON THE DRAWING OR THE OWNER. CONSTRACTOR TO CONFIRM THE WOOD MULCH SUPPLIED IS FREE OF ANY FOREIGN CHUNKS, STICKS, SOILS, STONES, CHEMICALS, SALT AND ROOTS, AND IS NON-MATTING.

ALL LANDSCAPE BEDS ALONG THE BASE OF THE BUILDING TO RECIEVE 75MM DEPTH OF DECORATIVE ROCK MULCH W/ WEED BARRIER FABRIC INSTALLED BELOW.

4) GROWING MEDIUM

IMPORT GROWING MEDIUM SHALL BE PLACED AT 300MM DEPTH IN ALL PLANTING AREAS AND 150MM DEPTH IN ALL TURF AREAS, AS SHOWN IN THE DRAWINGS (TREE PIT VOLUME BASED ON ZONING CALCULATION TABLE). GROWING MEDIUM IS TO MEET PROPERTIES OF TYPE 2P FOR PLANTING AREAS AND TREE PITS AND TYPE 2L FOR TURF AREAS, AS PER TABLE T-6.3.5.3 IN THE LATEST EDITION OF THE CANADIAN LANDSCAPE STANDARD. VOLUME FOR TREE'S BASED ON ZONING CALCULATIONS.

THESE DRAWINGS ARE A REPRESENTATION OF THE GENERAL DESIGN INTENT TO BE IMPLEMENTED ON THE SITE. THE CONTRACTOR IS RESPONSIBLE FOR CONTACTING A LANDSCAPE ARCHITECT IF ANY ADDITIONAL CLARIFICATION OR DETAILS ARE NECESSARY TO ACCOMMODATE SITE CONDITIONS OR ARCHITECTURAL DETAILS.

6) PLANT MATERIAL

ALL PLANT MATERIAL SUPPLIED AND PLACED BY THE CONTRACTOR MUST BE CERTIFIED TO BE FREE OF SUDDEN OAK DEATH (PHYTOPHTHORA RAMORUM), ACCORDING TO BCLNA OR CANADIAN FOOD INSPECTION AGENCY (CFIA) STANDARDS. THE CONTRACTOR WILL BE HELD RESPONSIBLE FOR THE SUPPLY AND PLACEMENT OF DISEASED PLANTS RESULTING FROM THEIR NEGLIGENCE TO THE OWNER. AT SOURCE OF SUPPLY, PLANT MATERIAL AND PRODUCTS SHALL BE AVAILABLE FOR OPTIONAL INSPECTION BY THE LANDSCAPE ARCHITECT. THE CONTRACTOR SHALL PROVIDE A (3) YEAR REPLACEMENT GUARANTEE ON ALL PLANT MATERIAL FROM THE DATE OF SUBSTANTIAL PERFORMANCE. 80% SURVIVAL RATE IS REQUIRED FOR BOND TO BE RETURNED TO CLIENT.

THE CONTRACTOR SHALL NOT SUBSTITUTE PLANT MATERIAL OR PRODUCTS WITHOUT THE WRITTEN CONSENT OF THE CLIENT AND WILL BE HELD RESPONSIBLE FOR THE REMOVAL AND REPLACEMENT OF ANY UNAPPROVED SUBSTITUTIONS.

8) COMPOSITE BASE SHEET

THE PROPOSED IMPROVEMENTS DISPLAYED ON THESE DRAWINGS ARE SUPERIMPOSED ON THE BASE SHEET. THIS BASE SHEET IS COMPILED FROM ARCHITECTURAL AND/OR ENGINEERING DOCUMENTS, THE TOPOGRAPHIC SURVEY, AND OTHER DATA MADE AVAILABLE TO THE DESIGNER. THE DESIGNER SHALL NOT BE HELD LIABLE FOR INACCURACIES, OMISSIONS, CHANGES, OR OTHER ERRORS ON THESE DOCUMENTS. THE COMPOSITE BASE SHEET IS PROVIDED ONLY AS AN AID AND THE CONTRACTOR SHALL BE RESPONSIBLE FOR REVIEWING THESE DOCUMENTS AND INCORPORATING/INTEGRATING ALL CONSTRUCTION AS REQUIRED TO ACCOMMODATE SAME.

9) CONTRACTORS' JOB SITE CONDITIONS

CONTRACTOR AGREES TO ASSUME SOLE AND COMPLETE RESPONSIBILITY FOR SITE CONDITIONS DURING CONSTRUCTION, THIS INCLUDES: SAFETY OF ALL PERSONS AND PROPERTY; THAT THIS REQUIREMENT SHALL APPLY CONTINUOUSLY AND NOT BE LIMITED TO NORMAL WORKING HOURS; AND THAT THE CONTRACTOR SHALL DEFEND, INDEMNIFY, AND HOLD THE OWNER AND THE LANDSCAPE ARCHITECT HARMLESS FROM ANY AND ALL LIABILITY, REAL OR ALLEGED, IN CONNECTION WITH THE PERFORMANCE OF WORK ON THIS PROJECT. CONTRACTOR TO REFER ENVIRONMENTAL PROFESSIONALS REQUIREMENTS FOR KEEPING THE SITE WITHIN REGULATIONS.

10) UTILITIES

THE CONTRACTOR IS RESPONSIBLE FOR CONTACTING THE UTILITY COMPANIES INVOLVED AND REQUESTING A VISUAL VERIFICATION OF THE LOCATIONS OF THEIR UNDERGROUND FACILITIES PRIOR TO CONSTRUCTION. MOST UTILITY COMPANIES HAVE ACCESS TO THE UNDERGROUND SERVICE ALERT PROGRAM CALL BEFORE YOU DIG'. THE CONTRACTOR OR ANY SUBCONTRACTOR FOR THIS CONTRACT SHALL NOTIFY MEMBERS 48 HOURS PRIOR TO PERFORMING EXCAVATION WORK BY CALLING THE TOLL-FREE NUMBER (800) 474 -6886. EXCAVATION IS DEFINED AS BEING 18 OR MORE INCHES IN DEPTH BELOW THE EXISTING SURFACE. THE CONTRACTOR IS CAUTIONED THAT EXCAVATION IS THE ONLY WAY TO REVEAL THE TYPES, EXTENT, SIZES, LOCATION, AND DEPTHS OF UNDERGROUND UTILITIES. HOWEVER, THE CONSULTANT CAN ASSUME NO RESPONSIBILITY FOR THE ACCURACY OR COMPLETENESS OF THE DELINEATION OF SAID UNDERGROUND UTILITIES, NOR FOR THE EXISTENCE OF OTHER BURIED OBJECTS OR UTILITIES NOT SHOWN ON THESE DRAWINGS.

PERMANENT AUTOMATIC UNDERGROUND IRRIGATION SYSTEM TO BE INSTALLED UNDER ALL SOFTSCAPE MATERIAL BY A QUALIFIED IRRIGATION PROFESSIONAL

12) GRADING & DRAINAGE

ALL STRUCTURES TO HAVE POSITIVE DRAINAGE AWAY FROM BUILDINGS.


ZONING CALCULATION

LANDSCAPE AREA - 'L.A.' (PER TABLE 7.2)

BERK COURT 3M FRONTAGE MIN. # OF TREE'S W/ IN 'L.A.': 16.5 lm = MIN. (1) TREES MIN. GROWING MEDIUM AREA: 40 SQM TOTAL, 3 SQM PERMEABLE PAVING

37 SQM TURF AND PLANTING = 93% SOFTSCAPE MIN. SETBACK FROM STRUCTURE: LARGE TREE 3.0m & MEDIUM TREES 2.2m MIN. GROWING MEDIUM PER TREE: (1) LARGE TREES 15 cu.m. per tree (2) MEDIUM TREES 12 cu.m. per tree

DRIVEWAY NOT INCLUDED IN CALCULATIONS

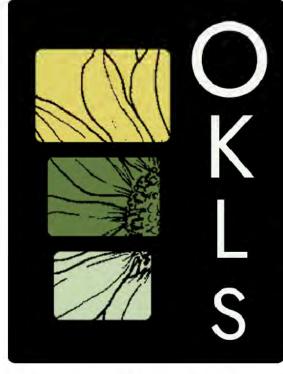


Okanagan Landscape Studio info@oklandscapestudio.com



Botanical Name	Common Name	Qty	Notes
Trees			
Acer saccharum	Sugar Maple	3	50cm cal.
Halesia carolina	Carolina silverbell	2	40cm cal.
Shrubs, Perennials & Ornament	al Grasses		
Buxus x 'Green Gem'	Green Gem Boxwood	20	1G CONT.
Calamagrostis x acu. 'Avalanche'	Avalanche Feather Reed Grass	28	1G CONT.
Hydrangea arbor. 'Annabelle'	Annabelle Hydrangea	14	1G CONT.
Molinia caerulea 'Moorhexe'	Moor Grass	20	1G CONT.
Salvia nem. 'Caradonna'	Caradonna Salvia	28	1G CONT.
Salvia nem. Caradonna	caractina sarria		

DETAILS

NOTE:1. ENSURE ROOT BALL IS THOUROUGHLY SATURATED PRIOR TO INSTALLATION.

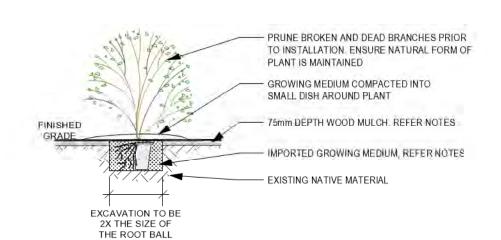


X SHRUB PLANTING IN GROUND - Typical Section

NOTE:

1. TREES TO BE SUPPORTED IN PLACE USING CEDAR STAKES & POLY MESH STRAP ASSEMBLY INSTALLED PER

1. TREES TO BE SUPPORTED IN PLACE USING CEDAR STAKES & POLY MESH STRAP ASSEMBLY INSTALLED PER MANUFACURERS SPECIFICATION. STAKES TO ONLY BE INSTALLED IN LOCATIONS OF HIGH WIND, STEEP SLOPES AND WHERE THE CALIPER OF THE TREE IS LESS THAT 5cm IN DIA.

2. ENSURE ROOT BALL IS THOUROUGHLY SATURATED PRIOR TO INSTALLATION. 3. WHEN TREE IS PLANTING IN ROCK MULCH OR TURF AREA, CONTRACTOR TO INSTALL 1 m DIA. RING OF

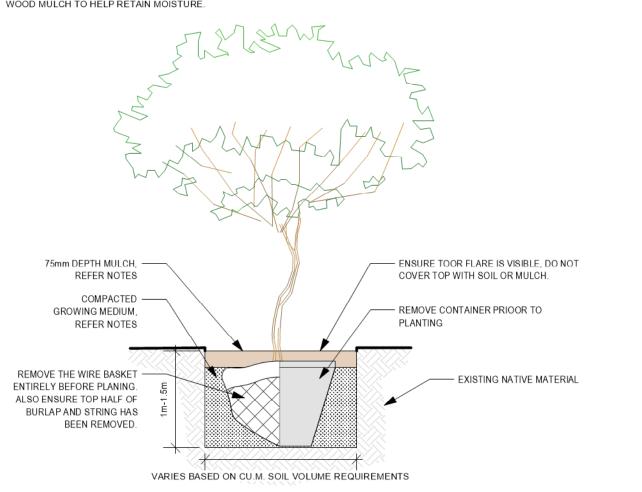

Initial Concept	09/08/24	01
Final Concept	30/10/24	02

PROJECT

MGDC DEVELOPMENT & MANAGEMENT. 1414613 BC Ltd.

SITE ADDRESS


764 Wilson Ave, Kelowan


SHEET TITLE

CONCEPT PLAN

Design by	SP
Project Number	24-031
Date	30/10/24
N —	SCALE 1:75 PAGE 24"x36"

SHEET NUMBER

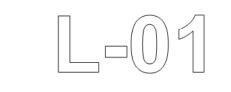

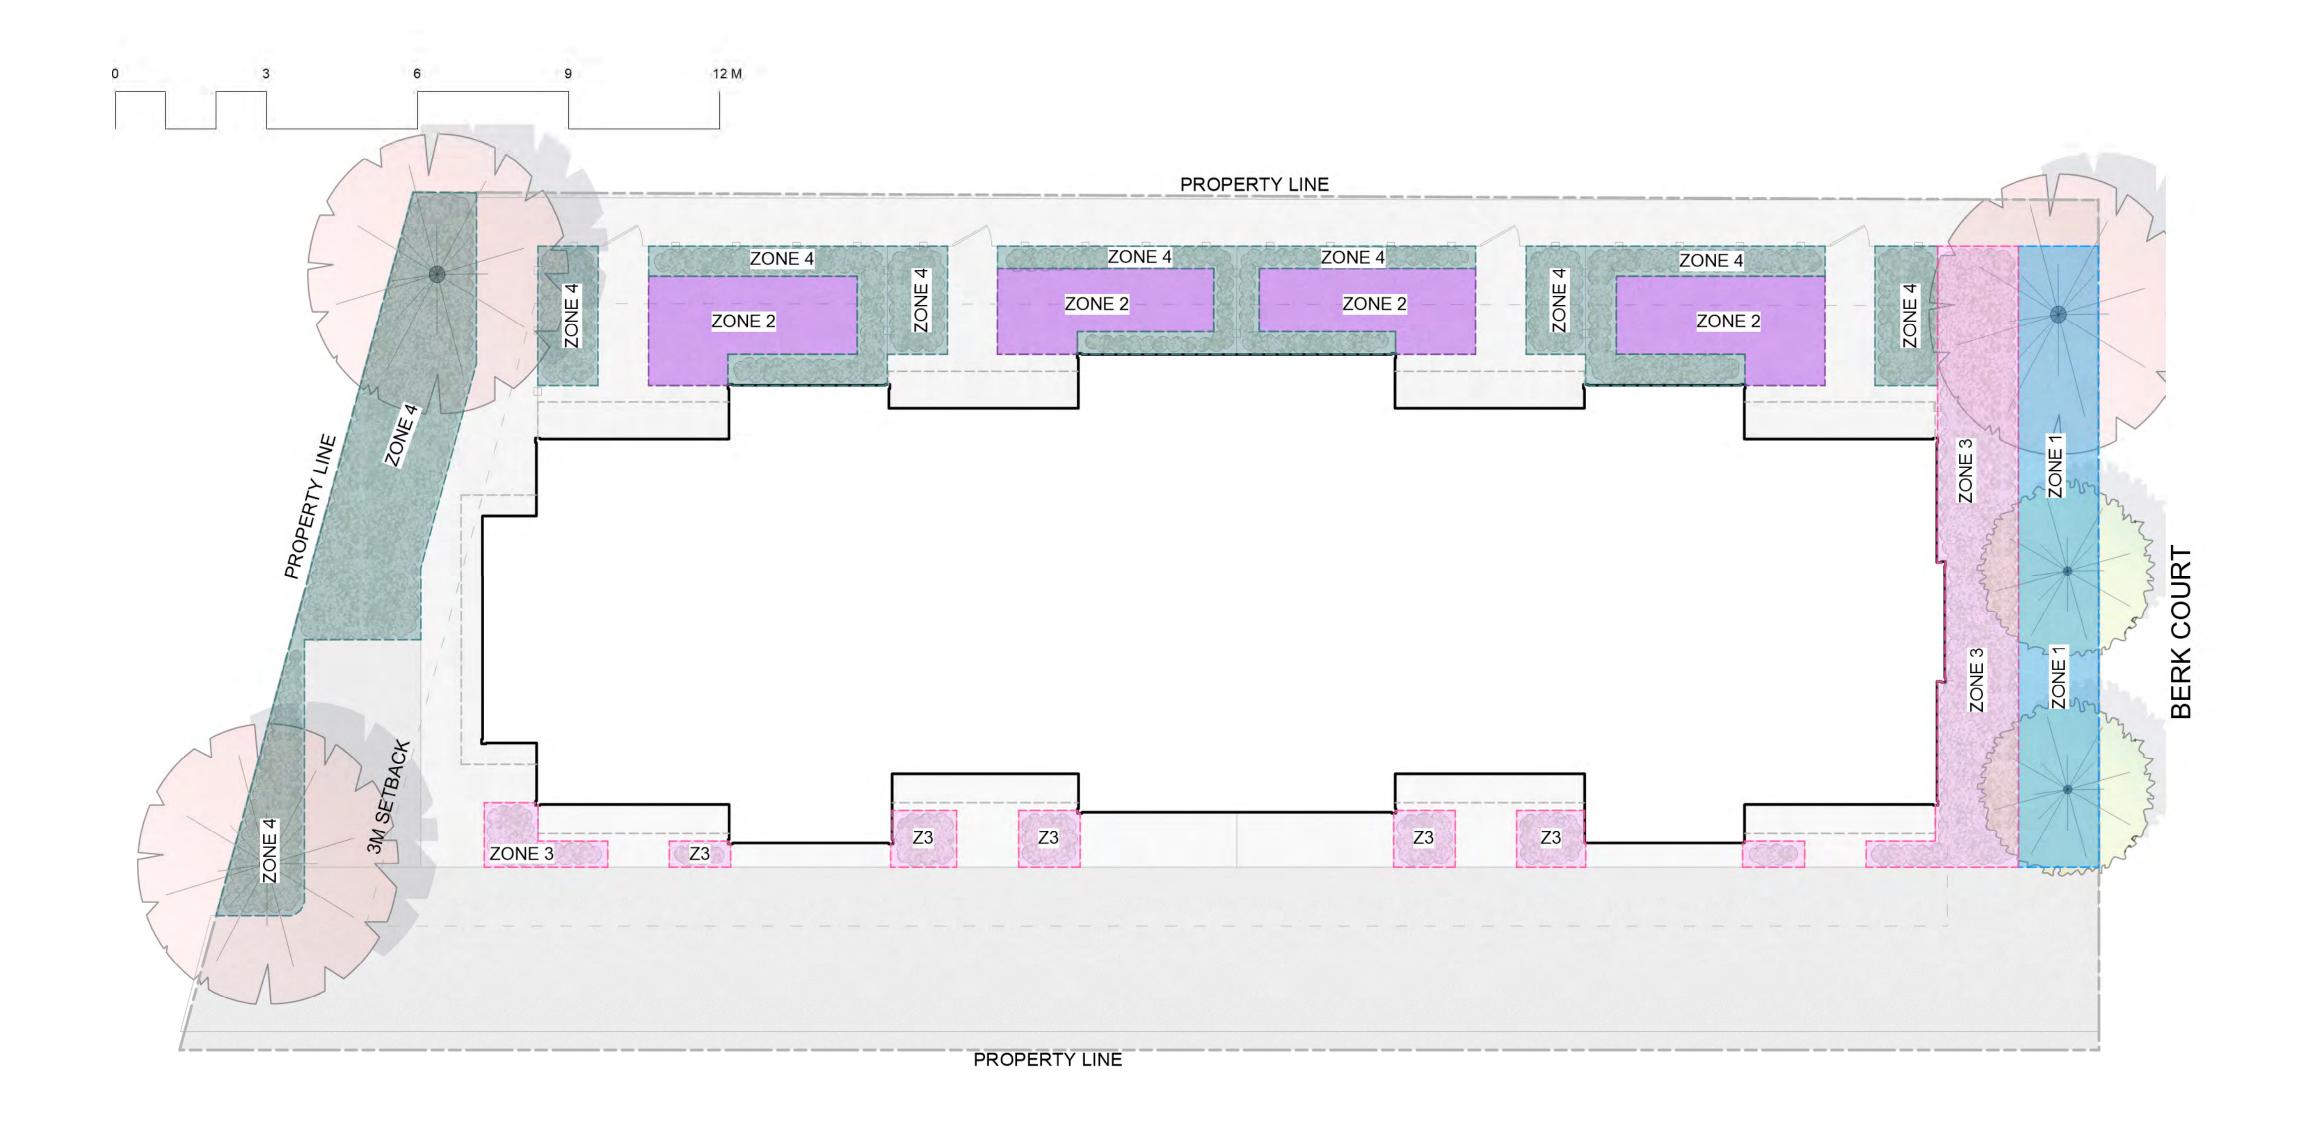

IRRIGATION NOTES

1. INSTALLATION PRACTICIES

ALL IRRIGATION INSTALLATION PRACTICES TO MEET IIABC STANDARDS, INSTALLED BY A CIT CERTIFIED PROFESSIONAL

2. SYSTEM DESIGN

SYSTEM IS DESIGNED BASED ON 10 GPM & 75 PSI AVAILABLE FROM EXTERIOR STUB OUT.

3. GRAPHIC CLARITY

DESIGN IS SHOWN SCHEMATICALLY FOR GRAPHIC CLARITY. CONTRACTOR TO INSTALL ALL COMPONENTS IN COMMON TRENCHES WHERE FEASIBLE AND INSIDE PLANTING AREAS WHENEVER POSSIBLE

4. IRRIGATION SLEEVES

ALL SLEEVES TO BE INSTALLED AT THE NECESSARY DEPTHS PRIOR TO PAVEMENT CONSTRUCTION AND EXTEND 300mm INTO LAWN OR PLANTING AREA

WATER CONSERVATION CALCULATIONS

LANDSCAPE MAXIMUM WATER BUDGET (WB) = 97 CU.M./YEAR

ESTIMATED LANDSCAPE WATER USE (WU) = 87 CU.M. / YEAR

WATER BALANCE = 10 CU.M. / YEAR

*SEE ATTACHED IRRIGATION APPLICATION FOR CALCULATION BREAKDOWNS

ZONE LEGEND

TOTAL AREA: 29 SQM.

ZONE #1: LOW VOLUME POP-UP SPRAY HEADS FOR WATERED MOWN LAWN AREAS. **TOTAL AREA**: 20 SQM.

MICROCLIMATE: NORTH FACING TURF AREA WITH MODERATE TREE COVERAGE ESTIMATED WU: 23 CU.M.

ZONE #2: LOW VOLUME POP-UP SPRAY HEADS FOR WATERED MOWN LAWN AREAS. **TOTAL AREA**: 27 SQM.


MICROCLIMATE: SOUTH FACING TURF AREA WITH MODERATE TREE COVERAGE ESTIMATED WU: 31 CU.M.

ZONE #3: HIGH EFFICIENCY SUBSURFACE DRIP IRRIGATION FOR MODERATE WATER USE PLANTING AREAS

MICROCLIMATE: EAST FACING PLANTING AREA WITH MODERATE COVERAGE FROM FENCE ESTIMATED WU: 13 CU.M.

ZONE #4: HIGH EFFICIENCY SUBSURFACE DRIP IRRIGATION FOR MODERATE WATER USE PLANTING AREAS **TOTAL AREA**: 45 SQM.

MICROCLIMATE: WEST FACING PLANTING AREA WITH MODERATE COVERAGE FROM FENCE ESTIMATED WU: 20 CU.M.

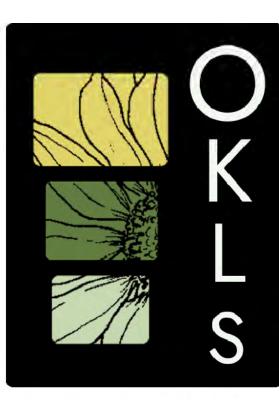

Okanagan Landscape Studio info@oklandscapestudio.com



Revision	Issue

DESCRIPTION	DATE	NO.
Initial Concept	09/08/24	01
Final Concept	30/10/24	02

PROJECT

MGDC DEVELOPMENT & MANAGEMENT. 1414613 BC Ltd.

SITE ADDRESS


764 Wilson Ave, Kelowan

SHEET TITLE

IRRIGATION LAYOUT PLAN

Design by	SP
Project Number	24-031
Date	30/10/24
N	SCALE 1:75 PAGE 24"x36"

SHEET NUMBER

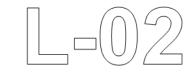



November 5, 2024

City of Kelowna **Urban Planning Department**1435 Water Street, Kelowna BC

V1Y 1J4

<u>Development Permit Application for RU1 – Large Lot Housing at 652 Berk Court, Kelowna BC</u>

Introduction

Dear Planning Staff,

The purpose of this application is to secure a Form and Character Development Permit for the proposed four-dwelling housing project at 652 Berk Court. The goal for this site is to create a project which is safe, livable, accessible, and establishes a sense of community for all new and existing residents of the neighbourhood. Along with recent Subdivision applications at various properties in the neighbourhood, the proposed four-dwelling project is anticipated to set a positive tone for infill housing in the community. The subject property is currently bare land with no existing dwellings.

Official Community Plan Objectives

In addition to many of the specific form and character guidelines from Sections 3.3.1 - 3.3.6, the project meets the following "Key Guidelines" for townhouse and infill projects in the 2040 OCP:

3.2.1 a - Configure building massing to reflect the general scale of buildings in the surrounding area (see 3.3.2).

Although the proposed building has utilized the maximum of 3 storeys, the third storey is 70% of the storey below. Both neighbouring properties to the north are 2 storeys. Features such as peaked roofs, square windows, and entry at-grade is provided to align with design and scale themes in the neighbourhood.

- 3.2.1 b For each unit, provide well-designed, generous outdoor amenity spaces at grade that offer privacy and screening, as well as attractive interfaces with the street and open spaces (see 3.3.1).
- 3.2.1 d Limit impermeable surfaces in landscaped areas and open spaces to maximize stormwater infiltration.

- 3.2.1 e Use building articulation, scaling, and setbacks to define individual units in a way that is clearly oriented to pedestrians rather than to vehicles and that emphasizes connection to the street (see 3.3.1).
- 3.2.1 f Orient building entries, windows, patios and balconies to face the fronting and flanking streets, with primary entries clearly visible and directly accessible from the sidewalk see (3.3.1).
- 3.2.1 g Building design elements, details and materials should create a well-proportioned and cohesive building design and exhibit an overall architectural concept (see 3.3.6).

In addition, this proposal conforms to the 2040 OCP – Future Land Use guidance of Suburban Residential, as ground-oriented residential is a supported use. The following pillars are met:

1. Stop planning new suburban neighbourhoods.

Creating sensitive infill within existing neighbourhoods reduces the desire for new suburban neighbourhoods to be planned. In turn, density is focused in areas with existing utilities and nearby transit, walking, and biking options.

2. Promote more housing diversity.

Infill housing allows for diverse housing options within Kelowna's suburban areas. Many tenants or property owners are searching for "missing middle" housing which provides appropriate parking, ground-oriented outdoor space, and multiple bedrooms for growing families.

3. Protect and restore our environment.

To enhance the site, the landscape plan proposes that 5 trees will be planted in landscape areas, which will significantly improve soil and water consumption, carbon storage, provide shade, and improve air quality on the site. In addition to trees; an abundance of turf, rock mulch, and ornamental plantings will be distributed around the site.

4. Prioritize sustainable transportation and shared mobility.

The subject property is located 175.0m from Gordon Drive which contains a bicycle network. In addition, Gordon Drive is a BC Transit bus route; therefore, residents of the subject property have the opportunity to access public transit or a bike lane within a short distance of their doorstep.

Site Layout

As shown on the attached drawing set, the proposed building contains 4 dwelling units in total. The building is 3 storeys with a height of 9.439m to the mid-point of the roof. The proposal conforms to all setbacks and regulations under the RU1 – Large Lot Housing zone, and parking for vehicles is located in a private garage for each unit. Parking requirements are met as part of this application with 1 parking stall per unit. Four 360L carts are provided on the west side of unit 4 with appropriate screening to blend with the building façade. 2 carts will contain garbage, and 2 carts will contain recycling. It is anticipated that this location is out-of-sight from the public eye, yet

accessible for tenants to roll the carts to the street on garbage day. A permeable pathway allows all tenants to access the street frontage from their rear yard. In addition, emergency services can easily access all 4 units from Berk Court.

The development group for the subject property are also involved in the subdivision directly south at 654 Buck Road. To improve site layout and function for all parcels involved, a shared laneway is provided at a width of 6.5m. The laneway encompasses a width of 3.25m on each parcel. An Access Easement will be registered at the time of Building Permit.

Fortis has issued an electrical plan which shows an underground service to the subject property. A transformer will be installed at 654 Buck Road, south of the subject property.

Design Details and Neighbourhood

The form and character of the proposed building has been designed with a traditional façade, which incorporates quality materials and building articulation to create architectural interest in the neighbourhood. The proposed main exterior of the building will be finished with several materials such as horizontal cement-fibre siding, board and batten, smart trim board, and laminate shingles. Each façade will contain projections which add value to the shape of each unit. Colours include; arctic white / abyss (black) siding, onyx (black) smart trim board, and onyx (black) board and batten. All soffits, roof shingles, and window frames will be finished in black. Front doors and garage doors will be coloured white to contrast the door frames and board and batten.



Figure 1 – Proposed building adjacent to Berk Court.

Suburban areas such as the Berk Court neighbourhood were recently zoned to allow for infill development. The design of the proposed building aims to create a diversity of residential concepts while keeping existing features found in the neighbourhood such as peaked roofs, square windows, garage parking at-grade, and front door entry at-grade. The privacy of neighbouring properties was carefully considered during the design stage. For example, the north setback has been increased to 2.965m at its closest point (3.6m in most areas) to allow private yards for each unit and additional

separation from the neighbouring property. Although windows are provided on the north elevation, the neighbouring dwelling to the north does not have windows on their south elevation, which reduces any privacy concerns. The existing fence and mature tree add additional privacy. Similarly, the proposed building as part of this application does not contain windows on the west elevation to respect the privacy of the neighbouring property to the west. 2 large trees are provided at the rear lot line and the setback has been increased to 3.737m at its closest point.

To compliment the external building finish of black and white, 3 trees are proposed within the front landscape area, including 1 large-sized sugar maple and 2 medium-sized carolina silverbell trees. The red and green colour combination of the proposed trees, ornamental plantings, and turf will appear very attractive against the black and white background of the proposed units, without overwhelming the site due to an abundance of colour. Windows are provided along the left and upper portions of the front façade, with respect to the proposed trees encompassing the majority of this building face.

Landscaping and Private Amenity Space

The site is designed with a variety of trees, ornamental plantings, rock mulch, and turf. 5 trees will be planted to meet landscape area regulations and to improve environmental, social, and visual conditions on the site. The existing tree at the southwest corner will be removed and replaced by the large maple tree in a slightly different location as shown on the landscape plan.

All units have private amenity space which is integrated in the form of at-grade turf and planting areas. The road frontage has been sensitively designed to transition from public space to private space with the use of landscaping. Decorative ornamental plantings, trees, and turf will soften the transition from the City boulevard to private property. All pathways will be permeable to assist onsite drainage during weather events.

Restrictive Covenant

In 1969, a Building Scheme was registered as a Restrictive Covenant on title for the property which previously existed at this location (Lot 14, Plan 18928). The Covenant is registered between the Builder and the Landowner at the time. The City of Kelowna is not listed as a charge holder. In 2010, Lot 14 was subdivided to become Lots 1 and 2, Plan EPP5534. The Covenant is to be handled concurrently to the Development Permit process via our legal team.

Target Focus

The topic of infill housing has been at the forefront of discussion in recent months. Provincial mandates to increase housing density have been used as an attempt to combat the housing crisis in BC, using infill housing as a tool. As a result, local governments across BC have improved Zoning Bylaws to allow for flexible building designs in areas originally constructed as single-detached housing. Single family homes on large lots are becoming less desirable due to the maintenance, repair costs, and purchase price. Although the focus of multi-unit buildings are often catered towards the younger generation and young families, the proposed infill project will also provide a

housing option for all ages to enjoy if desired; such as middle-aged couples or families, students, or retirees.

Conclusion

The intention of this proposal is to create infill development in an area of Kelowna which is very walkable, bikeable, and has access to nearby amenities. Okanagan Mission Secondary, Anne McClymont Elementary, and Bellevue Creek Elementary are located within 1.0km. The South Gordon Village Centre provides opportunities for grocery, pharmacy, and other commercial needs. This newly developed Village Centre eliminates the obligation for Okanagan Mission residents to travel to Pandosy Village or Downtown. This proposal is anticipated to provide missing-middle housing at a time where the local housing market has been identified as unaffordable and short of supply. The design will blend into the existing form of the neighbourhood, while adding new housing stock with additional colours, features, and landscaping. We look forward to hearing your comments and feedback on the project.

Regards,

Jack Pawsey – Planner Urban Options Planning Corp. Authorized Signatory; Birte Decloux, RPP MCIP



ZONING ANALYSIS TABLE

ADDRESS: 652 Berk Ct.

ZONE: RU1 – Large Lot Housing

PROPOSAL: Development Permit Application for the form and character of a 4-unit infill housing project.

SITE CONTEXT	PROPOSAL
Future Land Use (2040 OCP)	Suburban Residential
Transit Supportive Corridor	No
Subdivision or Consolidation Required	N/A
Adjacent Land Uses	N: Single-Detached Housing S: Single-Detached Housing (2-Lot Subdivision in process) W: Single-Detached Housing E: Single-Detached Housing
Uses	Principal: Townhouses Secondary: N/A

DEVELOPMENT REGULATIONS	RU1 ZONE	PROPOSAL
SITE DETAILS		
Lot Area	450.0m ²	588.46m ²
Site Width	16.5m or 15.0m with lane or strata road	16.455m
Site Depth	30.0m	35.713m
Minimum Building Envelope Area	150.0m ²	364.13m ²
BUILDING DETAILS		
Site Coverage of Buildings	40% or 55% for 3-or-more units	230.40m ² (39.15%)
Site Coverage of Buildings, Structures, & Impermeable Surfaces	70% or 75% for 3-or-more units	Buildings: 230.40m ² Hardscape (laneway, driveways, parking): 140.56m ² Total: 370.96m ² (63.04%)
Unit Density	4 dwelling units per lot	4 dwelling units provided
Unit Density when Not Connected to Community Water or Sewer	1 dwelling unit per 1,000m ²	N/A
Private Open Space	No minimum requirement	Units 1 & 4: 23.34m ² yard space Units 2 & 3: 19.14m ² yard space

DEVELOPMENT REGULATIONS	RU1 ZONE	PROPOSAL
Maximum Gross Floor Area of a 3 rd storey relative to the 2 nd storey (this does not apply to dwellings with walkout basements) BUILDING DETAILS	70% maximum	All Units: Third storey = 69.69% of second storey
	11 Ome or 2 stores in	0.420m
Building Height Walkert Beament Height Front	11.0m or 3 storeys 9.0m	9.439m
Walkout Basement Height – Front or Flaking Yard		N/A
Walkout Basement Height – Rear Yard	12.5m	N/A
Height – Accessory Building or Structure	4.8m	N/A
Maximum Building Footprint per Accessory Building or Structure	90.0m ²	N/A
Water Meter Room	1 required	Meter room provided – west building elevation
Waste Bin Screening	Screening required	Screening provided – west building elevation
Minimum Cart Aisle Width	0.6m	1.1m
SETBACKS		
Front Yard	3.0m or 6.0m for garages facing the street (from back-of-curb or edge of road pavement, or edge of sidewalk)	3.227m
Rear Yard	3.0m or 1.5m from a lane	3.777m
Rear Yard for Accessory	1.5m	N/A
Structures	or 0.9m from a lane	
Side Yards	1.8m	N: 3.11m S: 3.762m
Side Yards for Accessory Structures or Carriage House	1.5m	N/A
Distance Between Detached Principal Buildings	2.5m	N/A
PARKING		
Four-or-Less Dwelling Units	Minimum 1.25 stalls and maximum 2.0	5 stalls provided
Outside of the Core Area Visitor Parking	stalls per 3-or-more bedroom unit Required for 5-or-more dwelling units	N/A
Parking Stall Dimensions	Regular-sized stalls – 2.5m x 6.0m plus obstructions (if any)	4 Stalls: Regular-sized stalls with no obstructions
Bicycle Parking – Short Term (5 dwelling units or more)	4 stalls or 1 per 5 units (whichever is greater)	N/A

DEVELOPMENT REGULATIONS	RU1 ZONE	PROPOSAL
PARKING		
Bicycle Parking – Long Term (if unit does not contain a garage)	0.75 stalls per bachelor, 1-bedroom, or 2-bedroom dwelling units 1.0 per 3-bedroom or more dwelling units	Garages provided
EV Chargers	Level 2 charging required	Level 2 charging provided per unit

LANDSCAPE REGULATIONS	ZBL 12375 – TABLE 7.2	PROPOSAL
LANDSCAPE DETAILS		
Minimum Number of Trees within Landscape Area	1 tree per 10 linear meters	16.455 linear meters: 3 trees provided
Minimum Growing Medium Area	75% soil-based landscaping groundcover in landscape areas • There is no minimum growing medium area required in front yard or flanking yard landscape area if soil cells are installed to accommodate the minimum on site trees within the front yard or flanking yard landscape area.	93% soil-based landscape
Tree Setbacks from Buildings, Raised Patios, and Balconies	Large: 3.0m radius from centre of tree up to the second storey of the building Medium: 2.0m radius from centre of tree up the second storey of the building Small: 1.0m radius from centre of tree up to the second storey of the building	Large Tree: 3.0m Medium Trees: 2.2m
Minimum Deciduous Tree Planting Stock Caliper	Large: 5.0cm Medium: 4.0cm Small: 3.0cm	See landscape plan
Minimum Coniferous Tree Planting Stock Height	250.0cm	See landscape plan
Minimum Ratio between Tree Size On-Site	Large: Min 50% Medium: No min or max Small: Max 25%	Large: 60% Medium: 40% Small: 0%
Minimum Growing Medium Volumes per Tree	Single Tree Pair Shared Large Tree 30 m³ 20 m³ 15 m³ Medium Tree 20 m³ 15 m³ 12 m³ Small Tree 15 m³ 12 m³ 10 m³	See landscape plan

JP Oct. 30, 2024